WESTERN PIEDMONT COMMUNITY COLLEGE CONCRETE MASONRY RETAINING WALL REPAIR DESIGN

DESIGN:

NOVA ENGINEERING & ENVIRONMENTAL 75 MADDOX ROAD, SUITE 102 BUFORD, GEORGIA 30518 770.904.7190 KHEINRICHS@USANOVA.COM

APPLICABLE CODES:

2018 NORTH CAROLINA BUILDING CODE WITH LOCAL AMENDMENTS AMERICAN CONCRETE INSTITUTE (ACI)
ACI 318-11 BUILDING CODE REQUIREMENTS FOR STRUCTURAL CONCRETE

TMS 406/602-11 BUILDING CODE REQUIREMENTS FOR AND SPECIFICATIONS FOR MASONRY STRUCTURES

DRAWING INDEX:

- F-1 COVER SHEET F-2 GENERAL NOTES
- PLAN VIEW
- F-5 FLAN VIEW
 F-5 WALL SECTIONS
- JOINT DETAILS


SCOPE OF WORK:

- DEMOLITION DISTRESSED PORTION OF CONCRETE MASONRY RETAINING WALL AND BENCH BACKFILL SOILS AS REQUIRED.
- REMOVE/DEMOLISH EXISTING SIDEWALK ADJACENT TO THE CMU RETAINING WALL AS REQUIRED.
- RECONSTRUCT A NEW REINFORCED GROUT FILLED CONCRETE MASONRY WALL WITH FLASHING, WATERPROOFING SYSTEM, AND BRICK VENEER,
- REINSTALL BRICK VENEER TO EXISTING CONCRETE RETAINING WALL.
- REINSTALL SIDEWALK PER CIVIL DRAWINGS
- RESTORE BACKFILL AND LANDSCAPING PER OWNERS REQUIREMENTS.







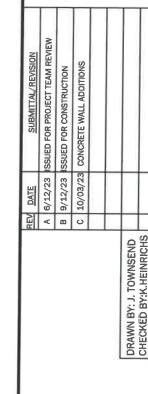

GENERAL NOTES:

- 1. CONTRACTOR SHALL COORDINATE AND SCHEDULE ALL SITE WORK WITH OWNER, ENGINEER SPECIAL INSPECTOR AND LOCAL ON-SITE MANAGEMENT. UNFINISHED WORK AREAS SHALL BE BARRICADED AS REQUIRED BY OWNER. STORAGE OF EQUIPMENT OR PLACEMENT OF MATERIALS SHALL ALSO BE COORDINATED WITH ON-SITE MANAGEMENT.
- 2. ALL CONSTRUCTION SHALL CONFORM TO THE REQUIREMENTS OF THE FOLLOWING CODES:
- CURRENT OSHA, FEDERAL, STATE AND LOCAL SAFETY REGULATIONS AND STANDARDS
- 3. CONTRACTOR SHALL BE RESPONSIBLE FOR CONTACTING ENGINEER CONCERNING ANY DISCREPANCIES, CHANGES IN THE INSTALLATION, OR DIFFERENCES OF THE ON-SITE CONDITIONS.
- 4. CONTRACTOR SHALL BE RESPONSIBLE FOR JOB SITE SAFETY PROTECTION OF PEDESTRIANS AND UTILITIES.
- 5. CONTRACTOR SHALL BE RESPONSIBLE FOR ALL PERMITS AND FEES.
- 6. CONTRACTOR SHALL SUBMIT TECHNICAL DATA SHEETS ON ALL PRODUCTS FOR OWNER'S/PROJECT ENGINEER'S APPROVAL PRIOR TO INSTALLATION.
- 7. CONTRACTOR SHALL BE RESPONSIBLE FOR SHORING, SAFETY OF OCCUPANTS, AND STABILITY OF THE STRUCTURE DURING THE WORK.

CONCRETE MASONRY UNITS NOTES:

- 1. CONCRETE MASONRY UNITS SHALL BE ASTM C90, NORMAL WEIGHT AGGREGATE, WITH F'CU = 2,800 PSI.
- 2. MORTAR SHALL CONFORM TO ASTM C270 PCL CLASS M.
- 3. BOND OF MASONRY BLOCKS SHALL BE RUNNING BOND
- 4. GROUT SHALL BE 4000 PSI STRENGH AT 28 DAYS. GROUT SOLID ALL CMU CELLS.
- 5. REINFORCING STEEL SHALL CONFORM TO ASTM A615 GR 60.
- 6. JOINT REINFORCEMENT SHALL BE SMOOTH WIRES AND CONFORM TO ASTM A951 SPACED 16" O.C.
- 7. INSTALL SEALANT JOINT AT BOTH ENDS OF THE NEW CMU RETAINING WALL SUCH AS NP1 URTHENE SEALANT BY MASTERBUILDERS WITH COMPATIBLE BACKER ROD
- 8. EXPOSED CONCRETE MASONRY SURFACES SHALL BE COATED WITH A XYPEX TWO-COAT CRYSTALLINE WATERPROOFING SYSTEM, CONSISTING OF ONE COAT CONCENTRATE AND ONE COAT MODIFIED XYPEX MATERIAL. SURFACE PREPARATION AND APPLICATION SHALL BE ACCORDING TO MANUFACTURES SPECIFICATIONS.




| | REV | DATE | SUBMITTAL/REVISION | |
|------------------------|-----|----------|--|--|
| | < | 6/12/23 | 6/12/23 ISSUED FOR PROJECT TEAM REVIEW | |
| | 8 | 9/12/23 | B 9/12/23 ISSUED FOR CONSTRUCTION | |
| | O | 10/03/23 | C 10/03/23 CONCRETE WALL ADDITIONS | |
| | | | | >] [|
| | | | | |
| DRAWN BY: J. TOWNSEND | | | | 75 MADDOX ROAD, SUIT |
| CHECKED BY:K.HEINRICHS | | | | BUFORD, GEORGIA 3C OFFICE: 770.904.71 |

WPCC RETAINING WALL REPAIR DESIGN 1001 BURKEMONT AVENUE MORGANTON, NORTH CAROLINA 28655
PREPARED FOR:

F-2

SHEET NUMBER

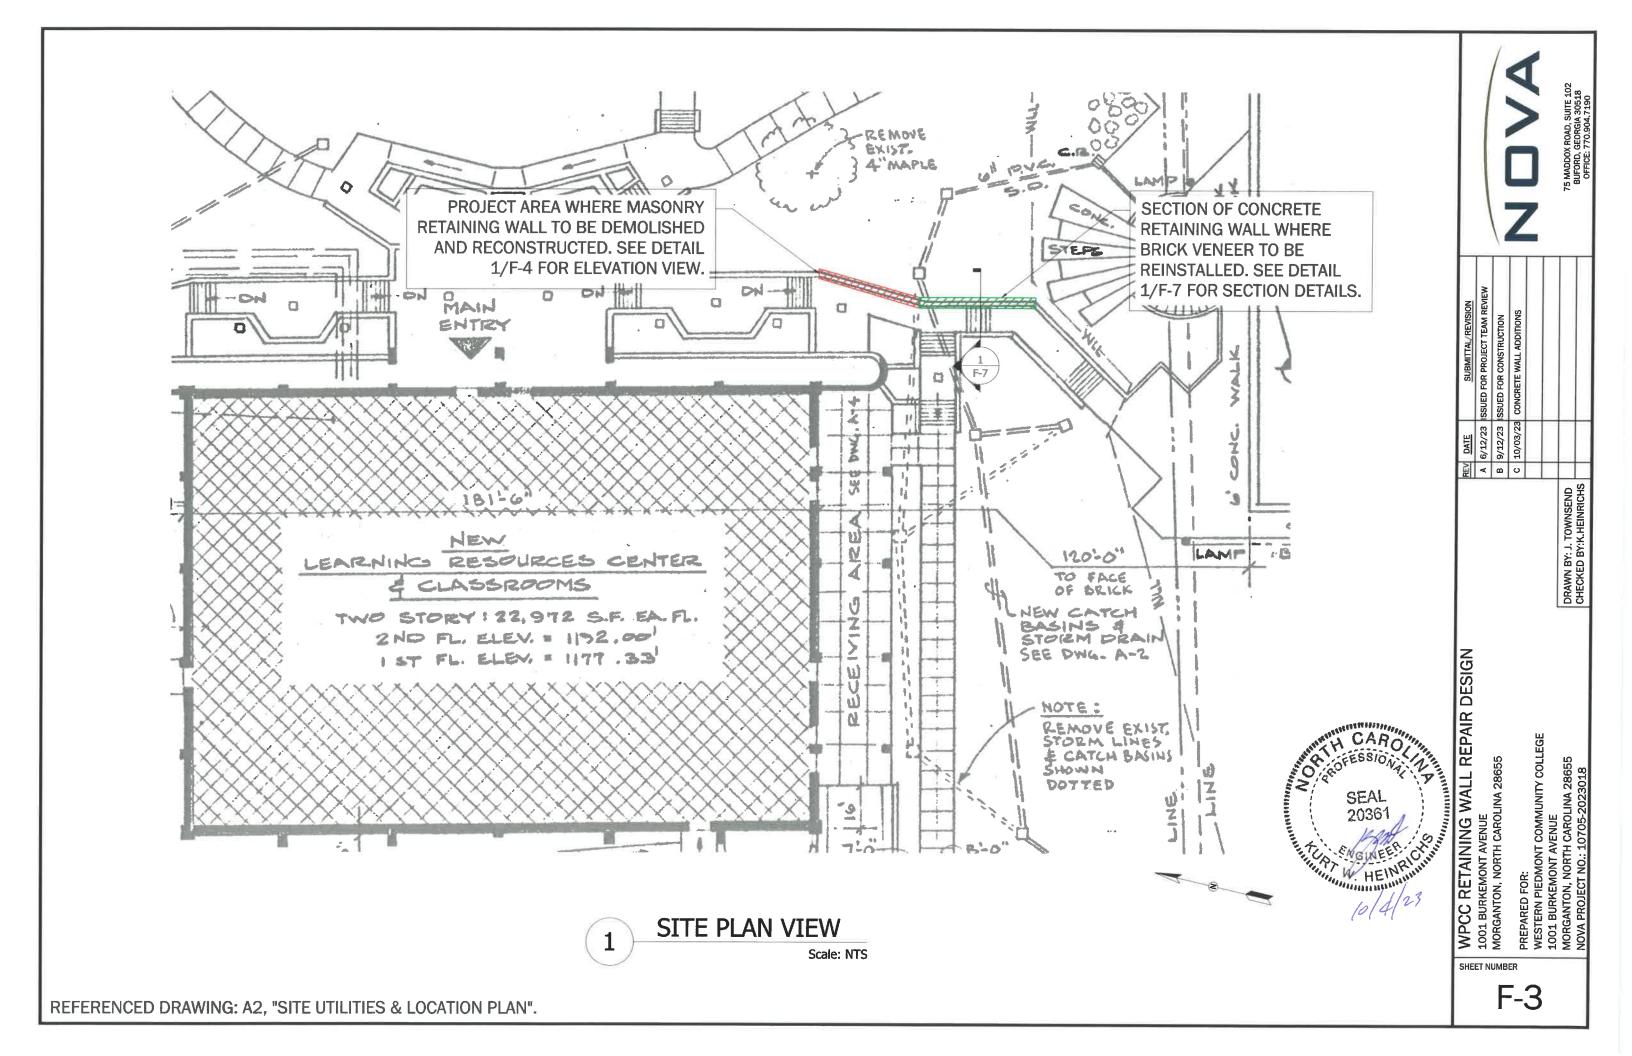



NSION ONS ONS

~ 4' (FIELD VERIFY)

PCC RETAINING WALL REPAIR
01 BURKEMONT AVENUE


ET NUMBER


ELEVATION VIEW
Scale: NTS

1

CONCRETE MASONRY RETAINING WALL SECTION TO BE DEMOLISHED AND

RECONSTRUCTED. NEW WALL ELEVATION TO MATCH EXISTING WALL AT ADJACENT STAIRCASE

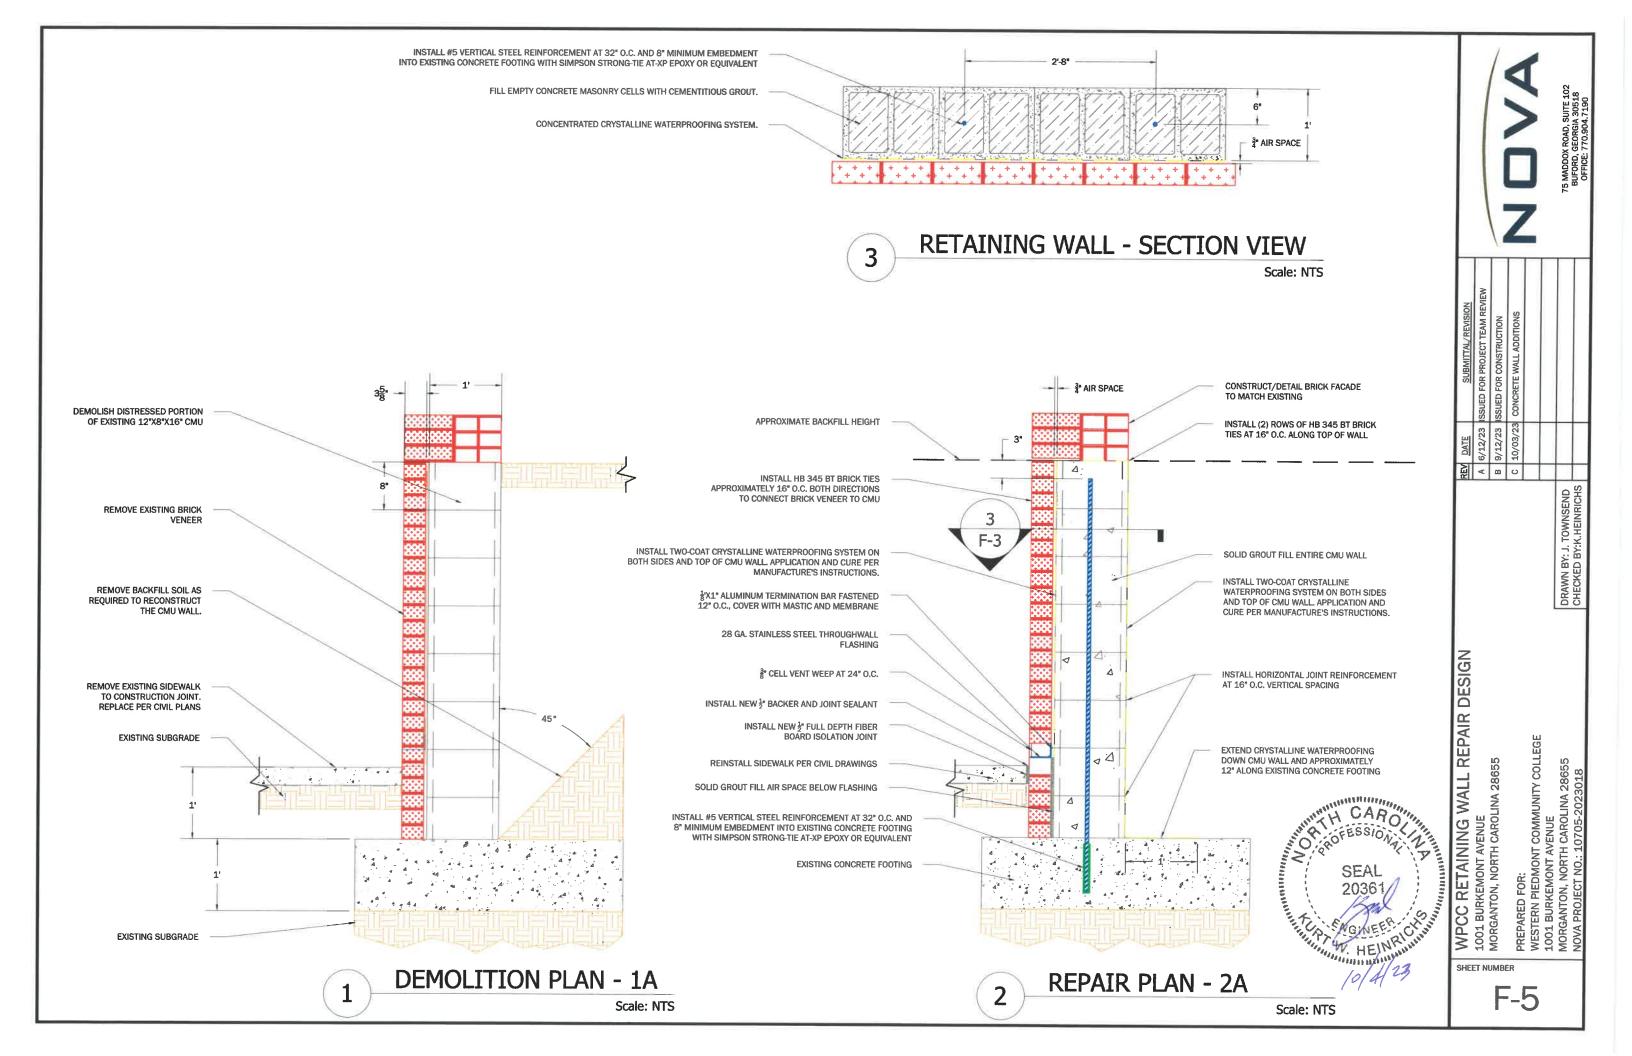

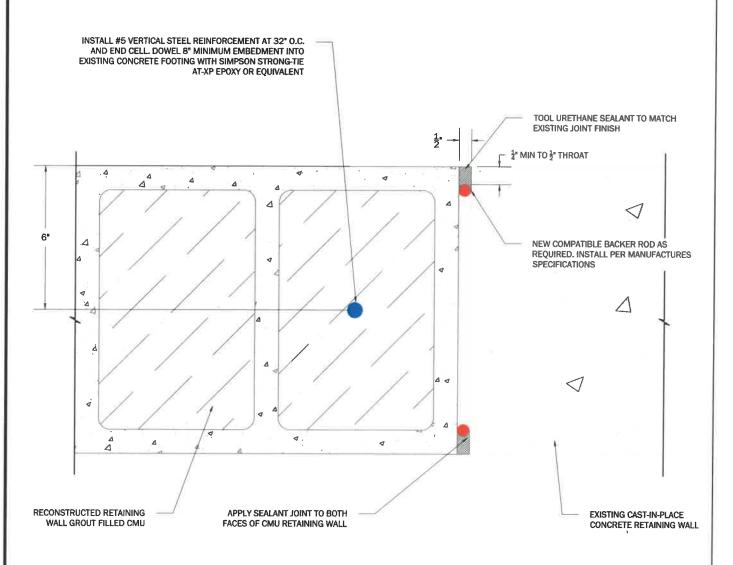

WPCC RETAINING WALL REPAIR DESIGN 1001 BURKEMONT AVENUE MORGANTON, NORTH CAROLINA 28655

SHEET NUMBER

F-6


HEV DATE SUBMITTAL/REVISION

A 6/12/23 ISSUED FOR PROJECT TEAM REVIEW

B 9/12/23 ISSUED FOR CONSTRUCTION

C 10/03/23 CONCRETE WALL ADDITIONS

CONTROL JOINT REPAIR DETAIL

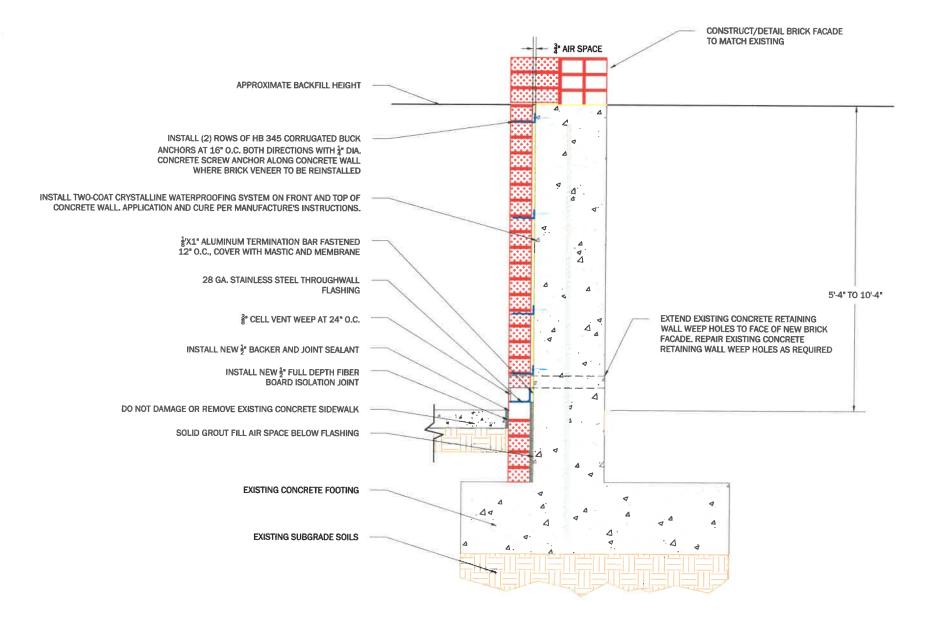

CONCRETE RETAINING FACADE REPAIR - SECTION VIEW

Scale: NTS



C B P

WPCC RETAINING WALL REPAIR DESIGN 1001 BURKEMONT AVENUE MORGANTON, NORTH CAROLINA 28655

SHEET NUMBER

F-7